
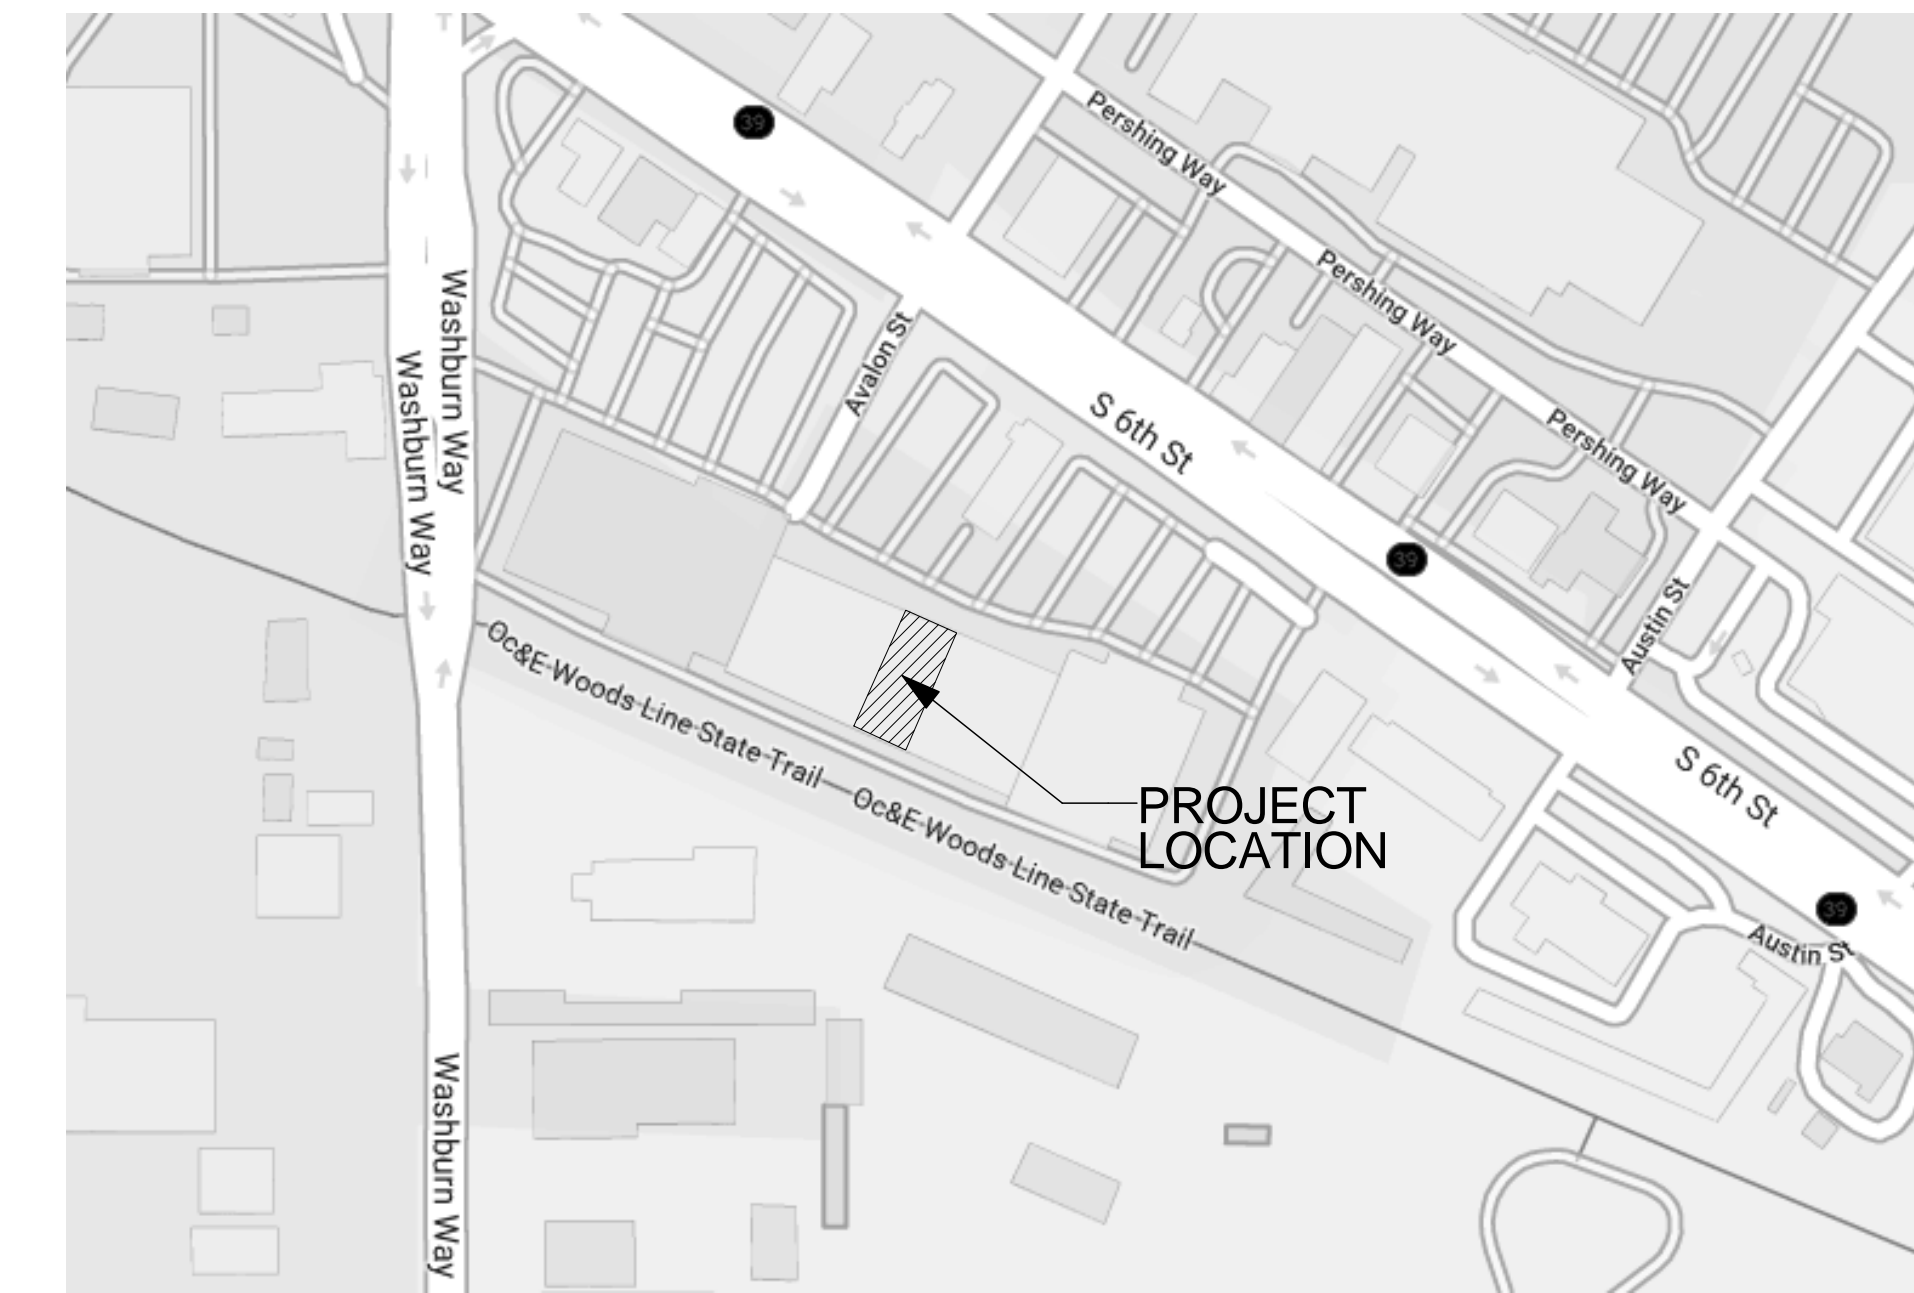


ULTA BEAUTY TI - (SHELL PACKAGE)

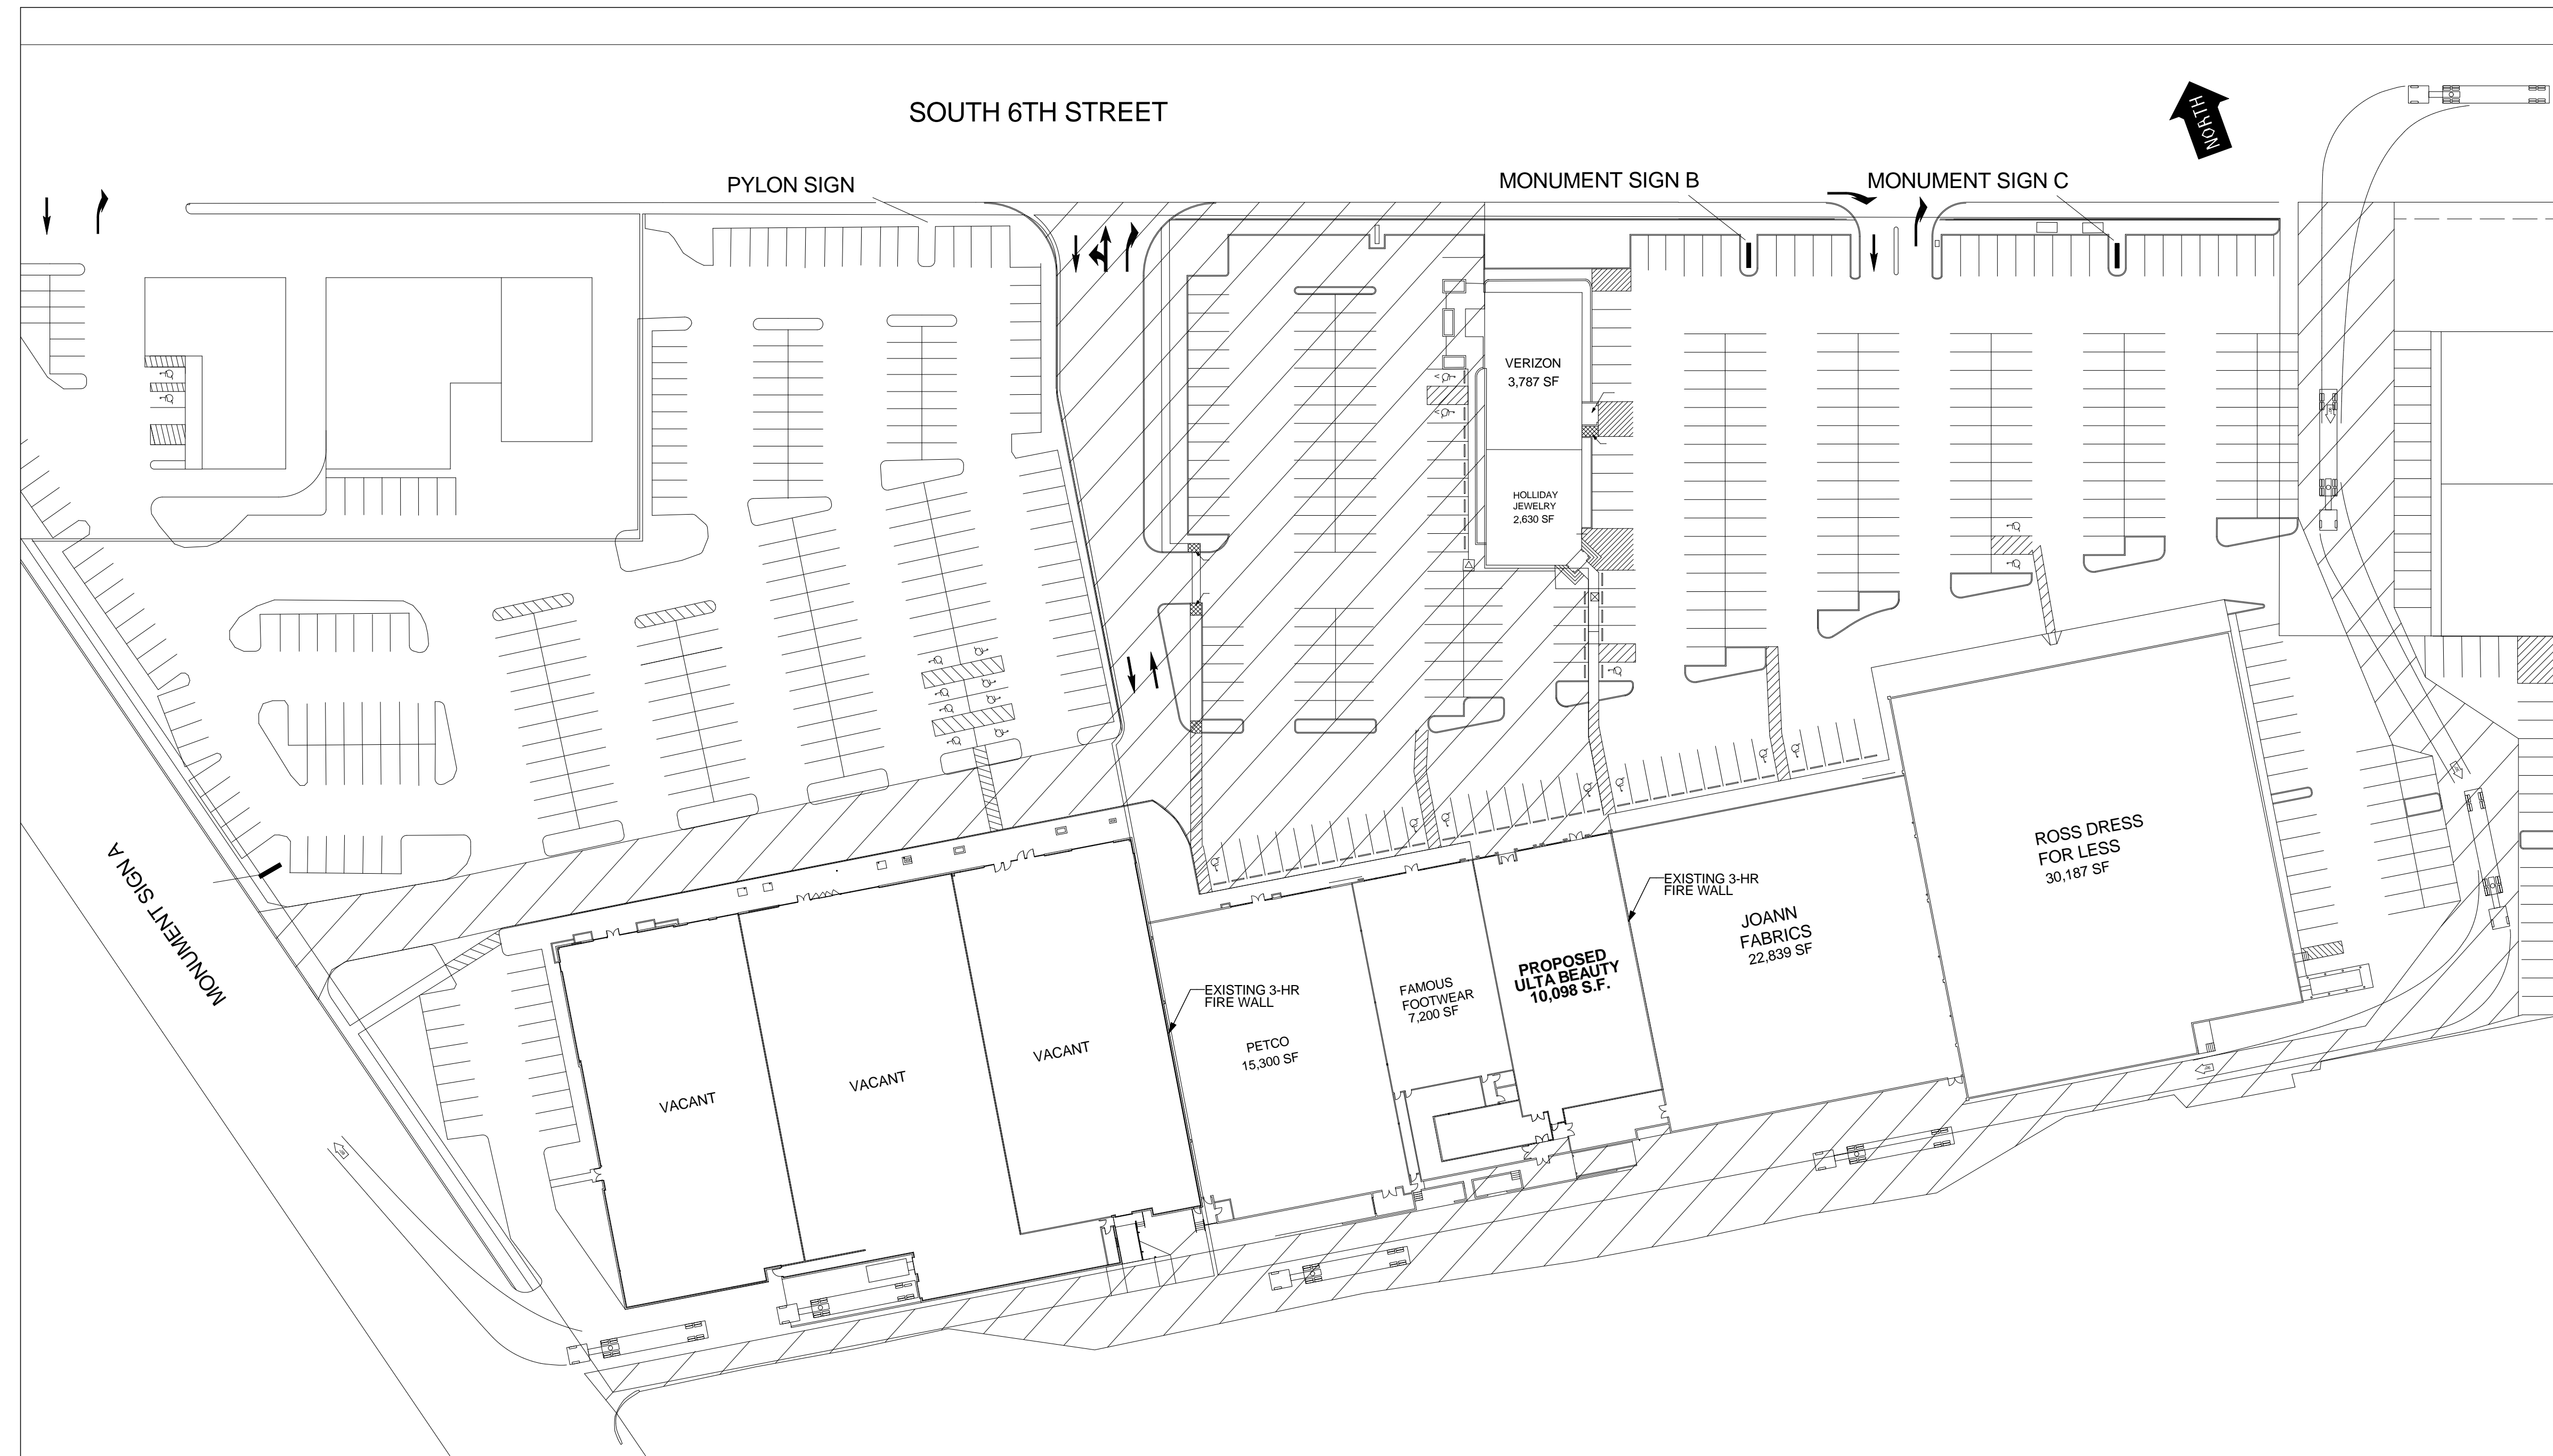

VICINITY MAP N.T.S.

CODE SUMMARY (ULTA BEAUTY)

THESE DRAWINGS ARE BASED ON THE 2014 OSSC.

CHAPTER 3 - USE & OCCUPANCY CLASSIFICATION
SECTION 302 M (MERCANTILE)
CHAPTER 5 - GENERAL BUILDING HEIGHTS AND AREAS
ALLOWABLE HEIGHT: 1 STORY/9,000 SF
ALLOWABLE INCREASE OF 300% (3 x 9,000 SF) FOR FULLY SPRINKLERED BLDG.
+9,000 SF + 27,000 SF = 36,000 SF
ALLOWABLE AREA: 36,000 SF
TENANT AREA = 10,098 SF
TOTAL BUILDING (FIRE) AREA: 32,598 SF
CHAPTER 6 - TYPE OF CONSTRUCTION
BUILDING IS FULLY SPRINKLERED
CHAPTER 9 - FIRE PROTECTION SYSTEM
BUILDING IS FULLY SPRINKLERED
CHAPTER 10 - MEANS OF EGRESS
TABLE 1004.1.1 MAXIMUM FLOOR AREA PER OCCUPANT
SECTION 1005.1 - MINIMUM REQUIRED EGRESS WIDTH
TOTAL OCCUPANTS = 313
REQUIRED WIDTH 0.2 PER OCCUPANT = 68"
ACTUAL WIDTH = 33' x 66" = 99"
TABLE 1021.1 MINIMUM NUMBER OF EXITS FOR OCCUPANT LOAD
TOTAL OCCUPANTS = 313
MINIMUM NUMBER OF EXITS = 2
NUMBER PROVIDED = 2

PER TABLE 1004.1.1 MAXIMUM FLOOR AREA PER OCCUPANT		
ROOM	AREA (S.F.)	OCCUPANCY PER 1004.1.1
SALES	9,298	30 S.F./OCC. = 310
BACKSTOCK/ LOADING AREA, ETC.	800	300 S.F./OCC. = 3
	10,098	313
TOTAL OCCUPANTS PER CODE = 313		

DEFERRED SUBMITTAL LIST

THE FOLLOWING SYSTEMS OR COMPONENTS ARE DESIGNED BY OTHERS BUT MAY REQUIRE REVIEW AND APPROVAL BY THE BUILDING OFFICIAL AS PRESCRIBED IN SECTION 107.3.4.2 OF THE 2014 O.S.S.C. AS STATED IN THE SECTION ABOVE, THEIR SUBMISSION MAY BE DEFERRED WHEN APPROVED BY THE BUILDING OFFICIAL.

- TENANT IMPROVEMENT PLANS
- FIRE SPRINKLER PLANS
- FIRE ALARM PLANS
- AWNING PLANS

SHEET INDEX

PAGE #	TITLE
A0.0	SITE PLAN AND CODE SUMMARY
A1.0	DEMOLITION PLAN & MAIN FLOOR PLAN
A2.0	ELEVATION, SECTION AND MISC. DETAILS
S1.0	STRUCTURAL SECTIONS
S2.0	HVAC REINFORCEMENT PLAN
M-1	MECHANICAL REFLECTED CEILING PLAN, NOTES, AND SYMBOLS
M-2	MECHANICAL SCHEDULES AND DETAILS
M-3	MECHANICAL SPECIFICATIONS
M-4	MECHANICAL SPECIFICATIONS
E0-1	DRAWING INDEX, SCHEDULES, NOTES & SYMBOL LIST
E0-2	ELECTRICAL ONE LINE DIAGRAMS
E0-3	PANEL SCHEDULES
E1-0	FLOOR PLAN-LIGHTING
E2-0	FLOOR PLAN-POWER & SPECIAL SYSTEMS
E3-0	ELECTRICAL SPECIFICATIONS
P-1	PLUMBING NOTES
P-2	PLUMBING PLANS AND NOTES
P-3	PLUMBING DETAILS
P-4	PLUMBING SPECIFICATIONS
P-5	PLUMBING SPECIFICATIONS

A SITE PLAN
A0.0 SCALE: 1" = 50'-0"



REVISIONS	No.	DATE	DESCRIPTION
	A	02/19	TENANT REQUESTED REVISIONS

PROJECT: **ULTA BEAUTY TI - (SHELL PACKAGE)**
LOCATION: **2870 S 6TH STREET, KLAMATH FALLS, OR 97603**

SHEET TITLE: **SITE PLAN AND CODE SUMMARY**
CLIENT: **DICKERHOOF PROPERTIES**

STABILITY ENGINEERING INC.
777 NE 2ND ST SUITE 200
P.O. BOX 2646, CORVALLIS, OR 97339
TEL: (541)223-5360 FAX: (541)223-5278

JOB NO. 19-0216
DATE: JUNE 10, 2019
DRAWN: PS
SCALE: AS SHOWN
SHEET

A0.0


REVISIONS	No.	DATE	DESCRIPTION
	A	02/19	TENANT REQUESTED REVISIONS

PROJECT: **ULTA BEAUTY TI - (SHELL PACKAGE)**
 LOCATION: **2870 S 6TH STREET, KLAMATH FALLS, OR 97603**

SHEET TITLE: **DEMOLITION PLAN & MAIN FLOOR PLAN**
 CLIENT: **DICKERHOOF PROPERTIES**




STABILITY ENGINEERING INC.
 777 NE 2ND ST SUITE 200
 P.O. BOX 2646, CORVALLIS, OR 97339
 TEL: (541)223-5360 FAX: (541)223-5278

JOB NO: 19-0216
 DATE: JUNE 10, 2019
 DRAWN: PS
 SCALE: AS SHOWN
 SHEET: **A1.0**



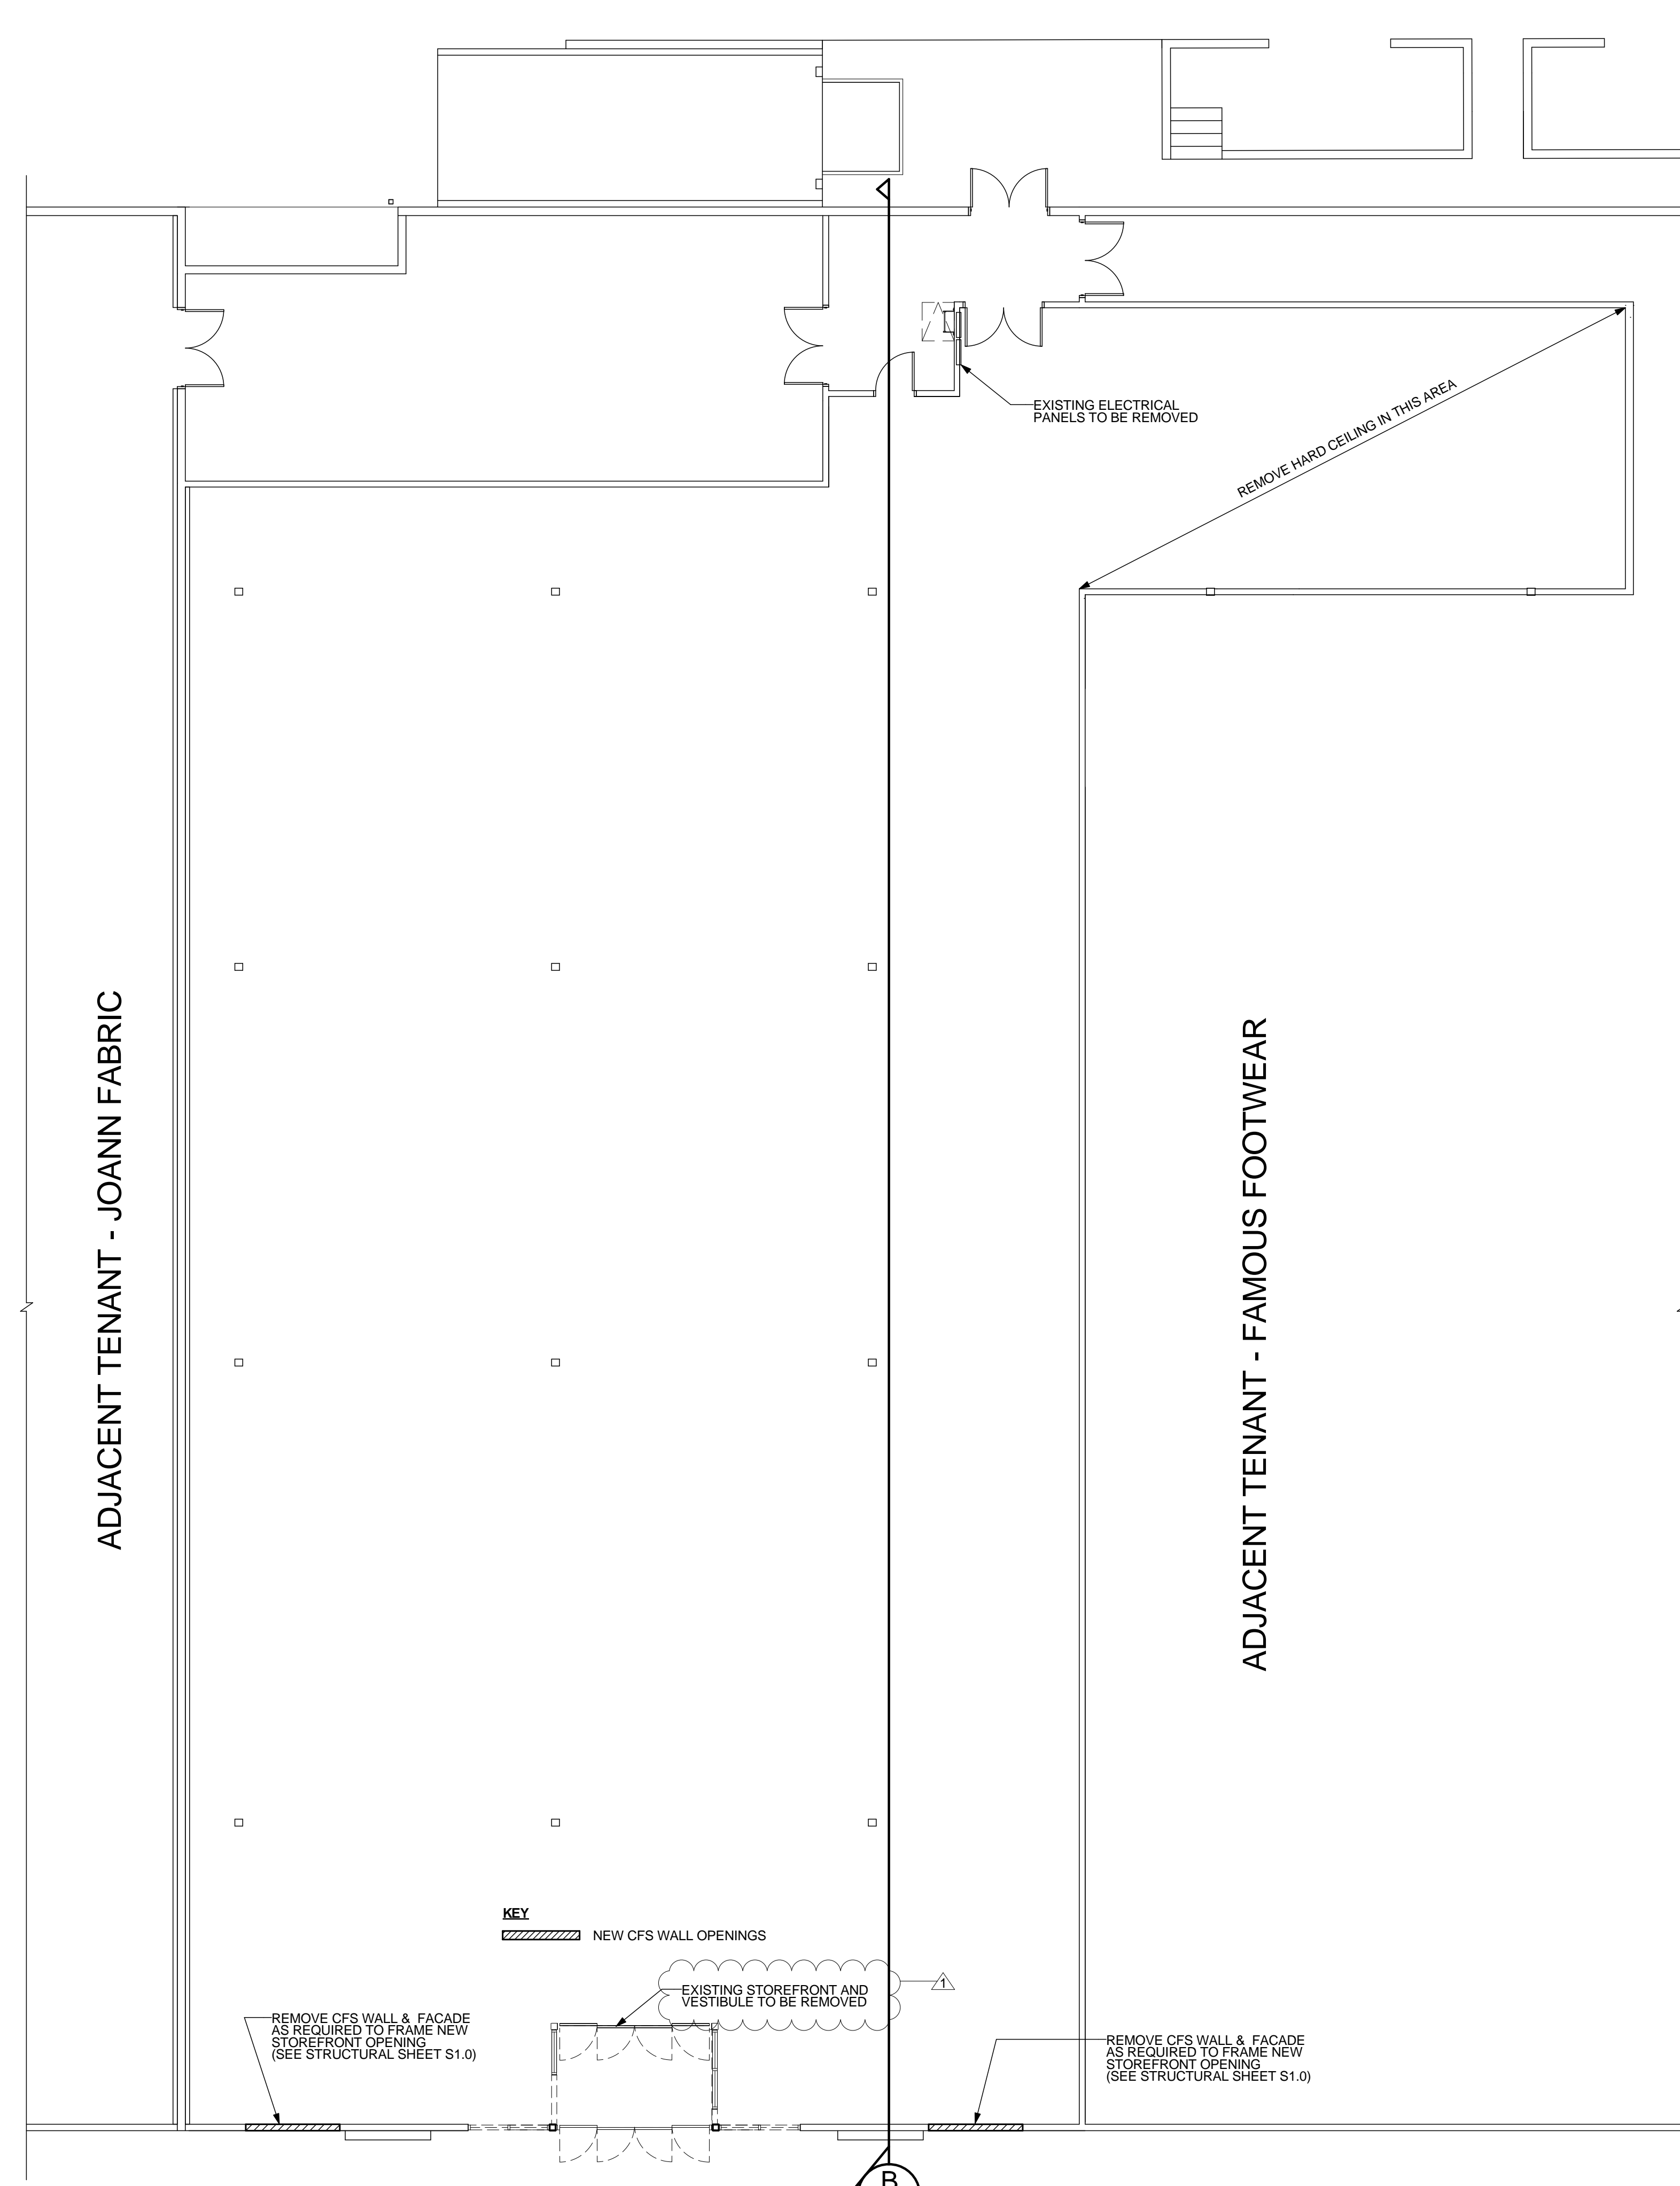



A1.0 DEMOLITION PLAN
 SCALE: 1/8" = 1'-0"

MAXIMUM WALL HEIGHT	STUD SIZE	SPACING	REMARKS	NOTES:
13'-6"	302S162-33	16" O.C.		1. ALL STEEL TO BE MIN. Fy = 33 KSI (A.I.A.) 2. ALL STUDS WITH GYP. BD. ON ONE SIDE TO BE BRACED WITH SPACER 5400 BRIDGING BAR @ 2'-0" O.C. VERTICALLY. SEE DETAIL C-A2.0. 3. GAUGE EQUIVALENT STUDS WILL NOT BE ACCEPTED. 4. RUNNER TRACK THICKNESS TO MATCH STUD. 5. ATTACH NEW LIGHT GAUGE STEEL WALLS TO SLAB WITH (2) 8D SURT NAILS @ 16" O.C.
16'-0"	302S162-43	16" O.C.		
18'-0"	302S162-54	16" O.C.		
20'-0"	302S162-68 ALT. 600S162-33	16" O.C.		
22'-0"	600S162-33	16" O.C.		
24'-0"	600S162-43	16" O.C.		
26'-0"	600S162-54	16" O.C.	Fy = 50 KSI	
28'-0"	600S162-54	16" O.C.	Fy = 50 KSI	
30'-0"	800S162-43	16" O.C.		

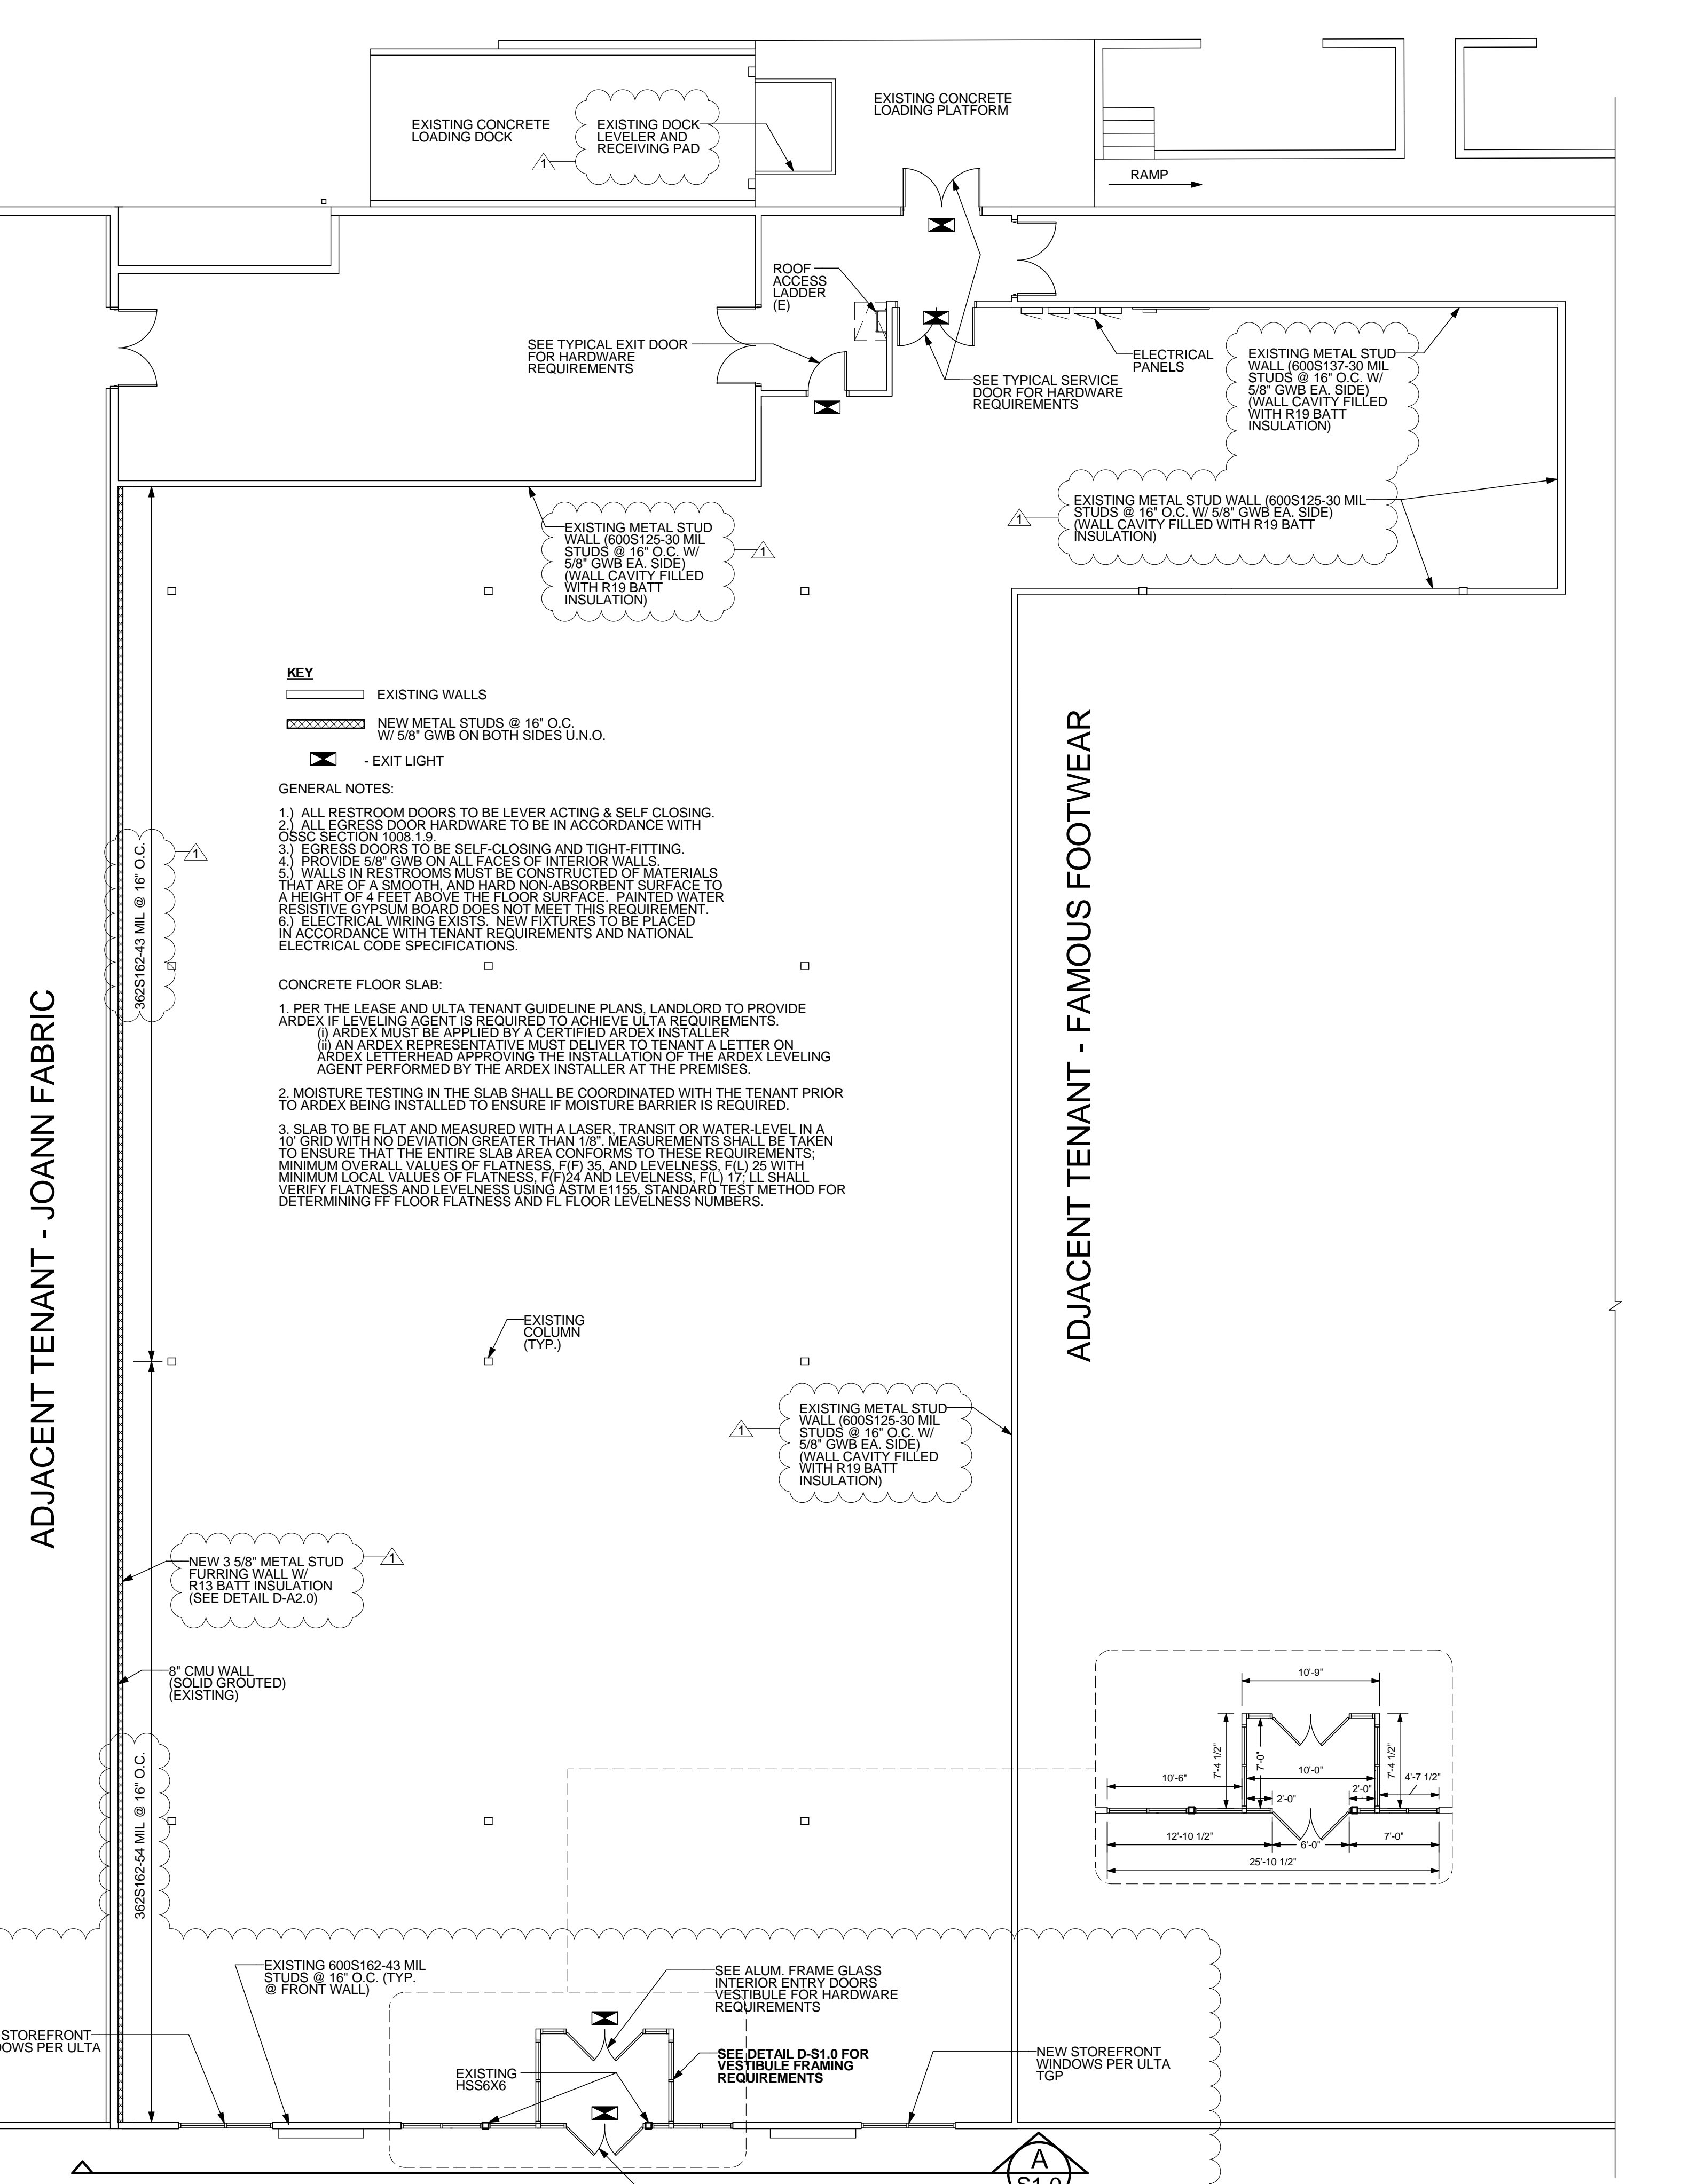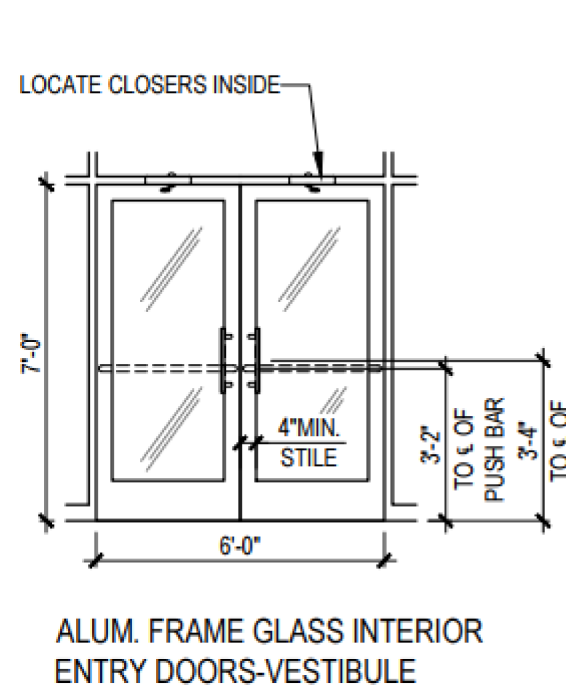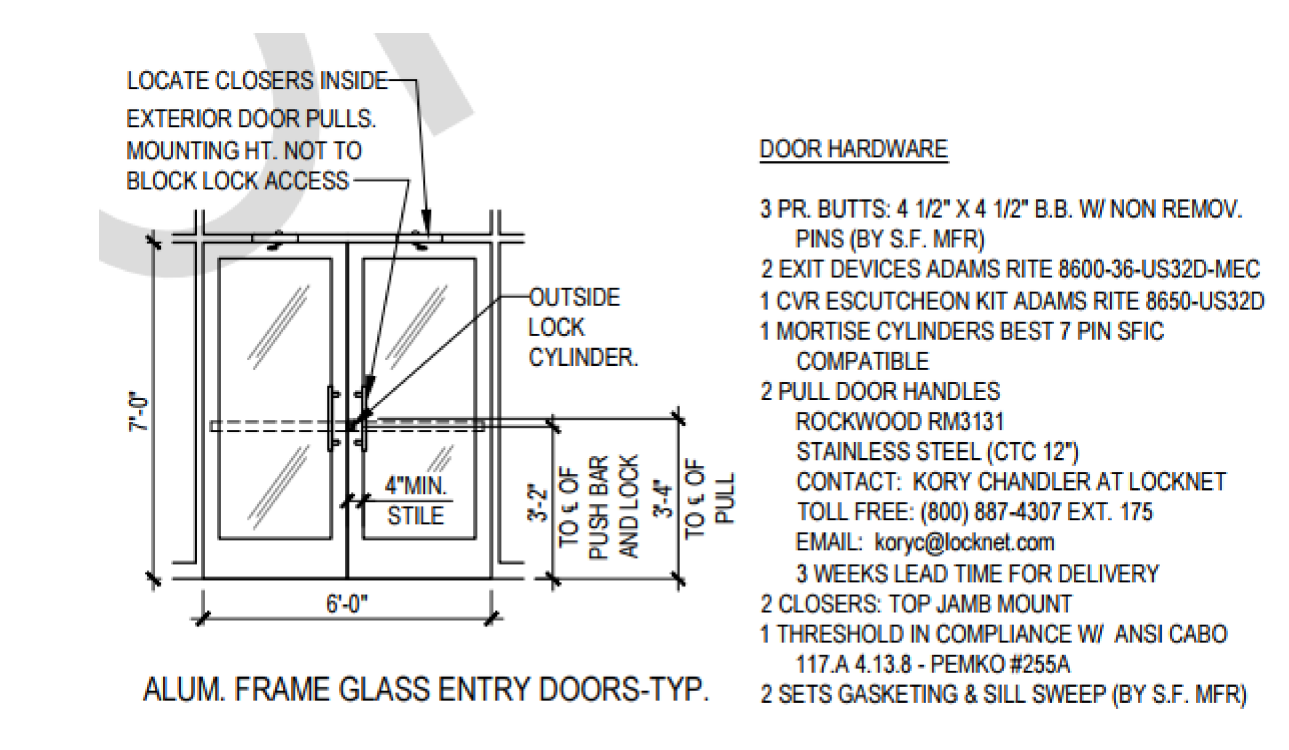






B1.0 MAIN FLOOR PLAN
 SCALE: 1/8" = 1'-0"

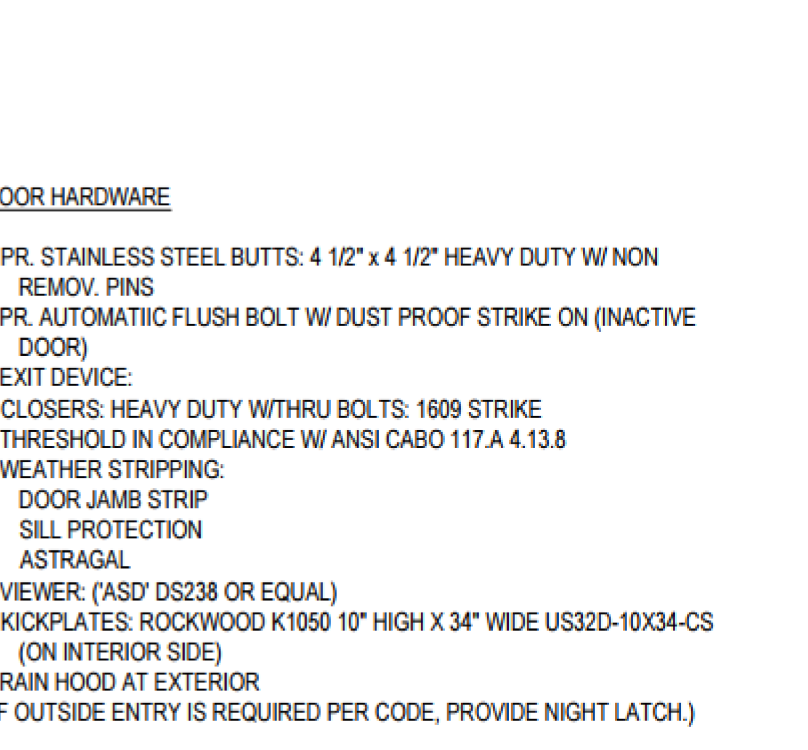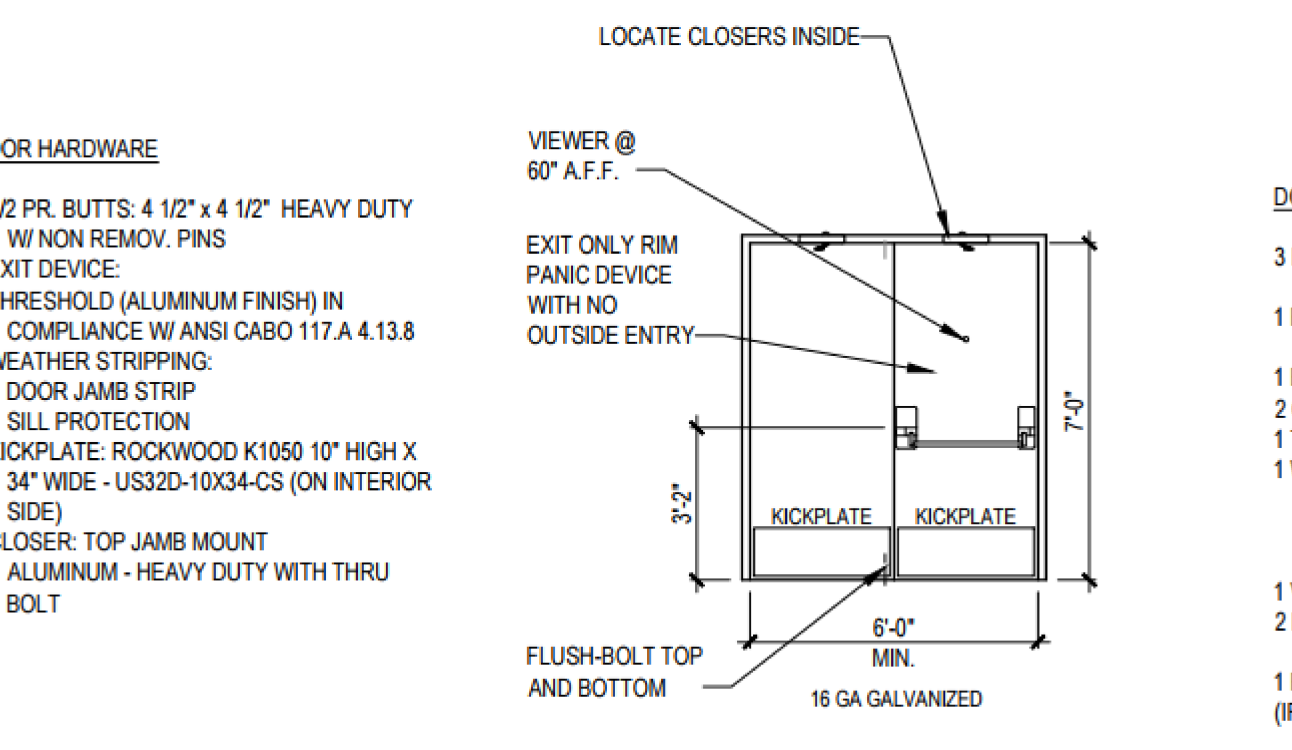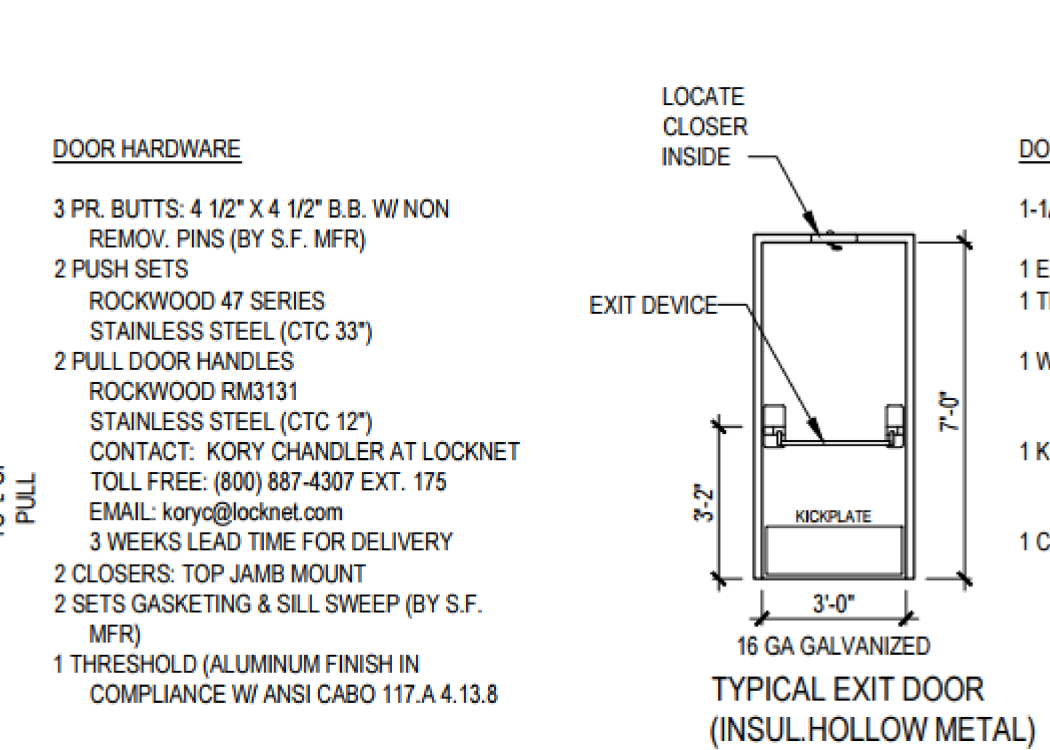

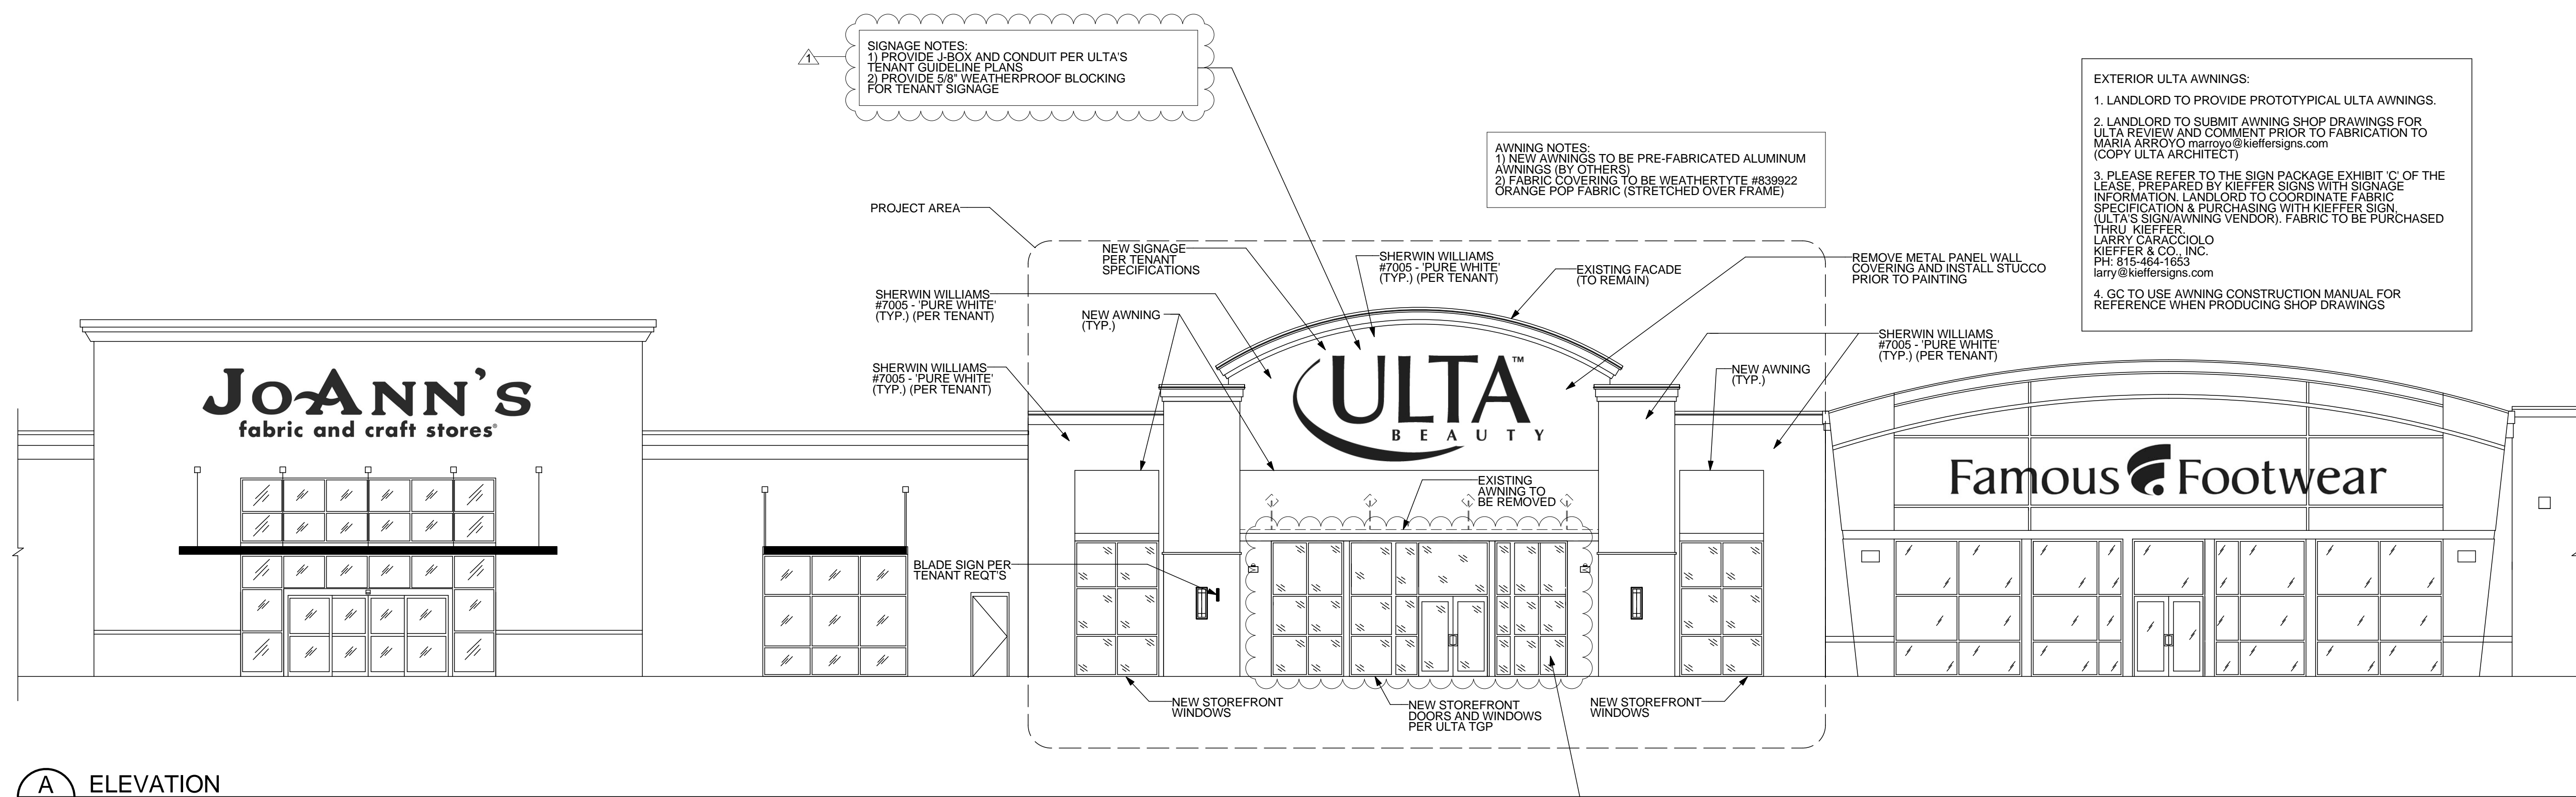

A ELEVATION
 A2.0 SCALE: 1/8" = 1'-0"

STOREFRONT NOTES:
 1) ULTA STOREFRONT GLAZING TO BE 1" INSULATED GLAZING.
 2) ULTA APPROVED STOREFRONT MANUFACTURERS: OLD CASTLE, YKK, KAWNEER
 3) PROVIDE CLEAR ANODIZED PREFINISHED SATIN ALUMINUM STOREFRONT

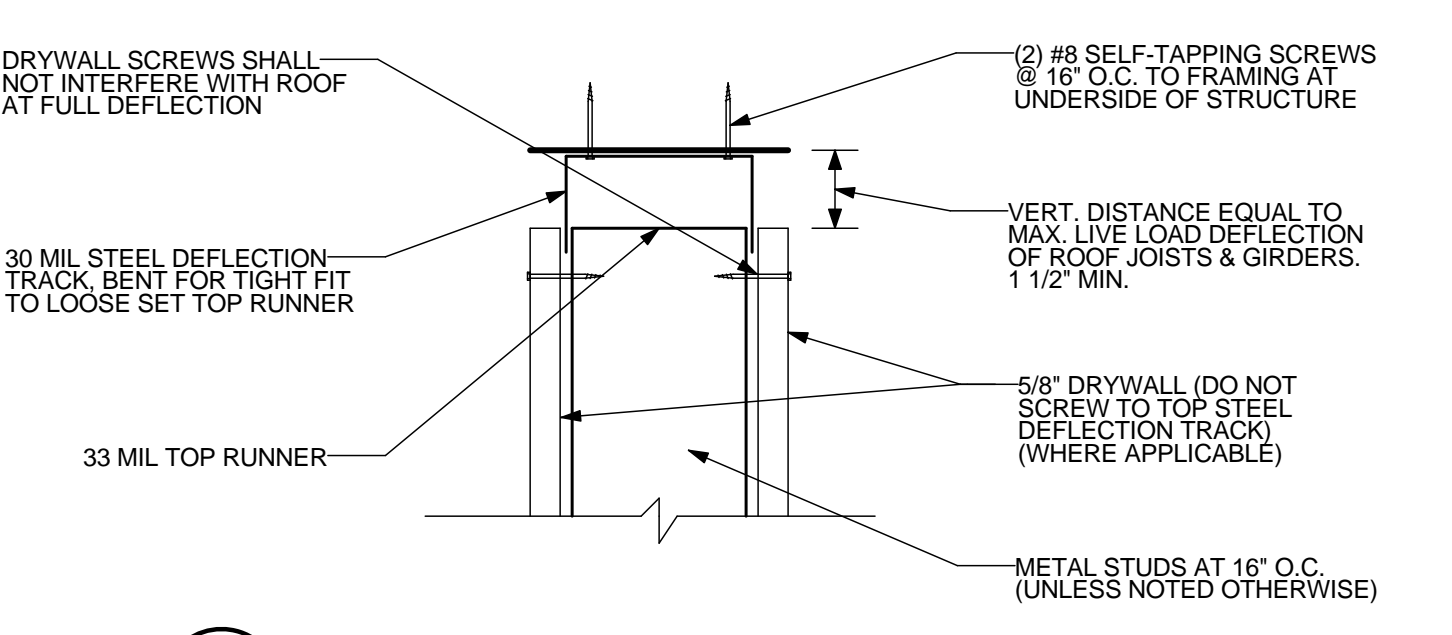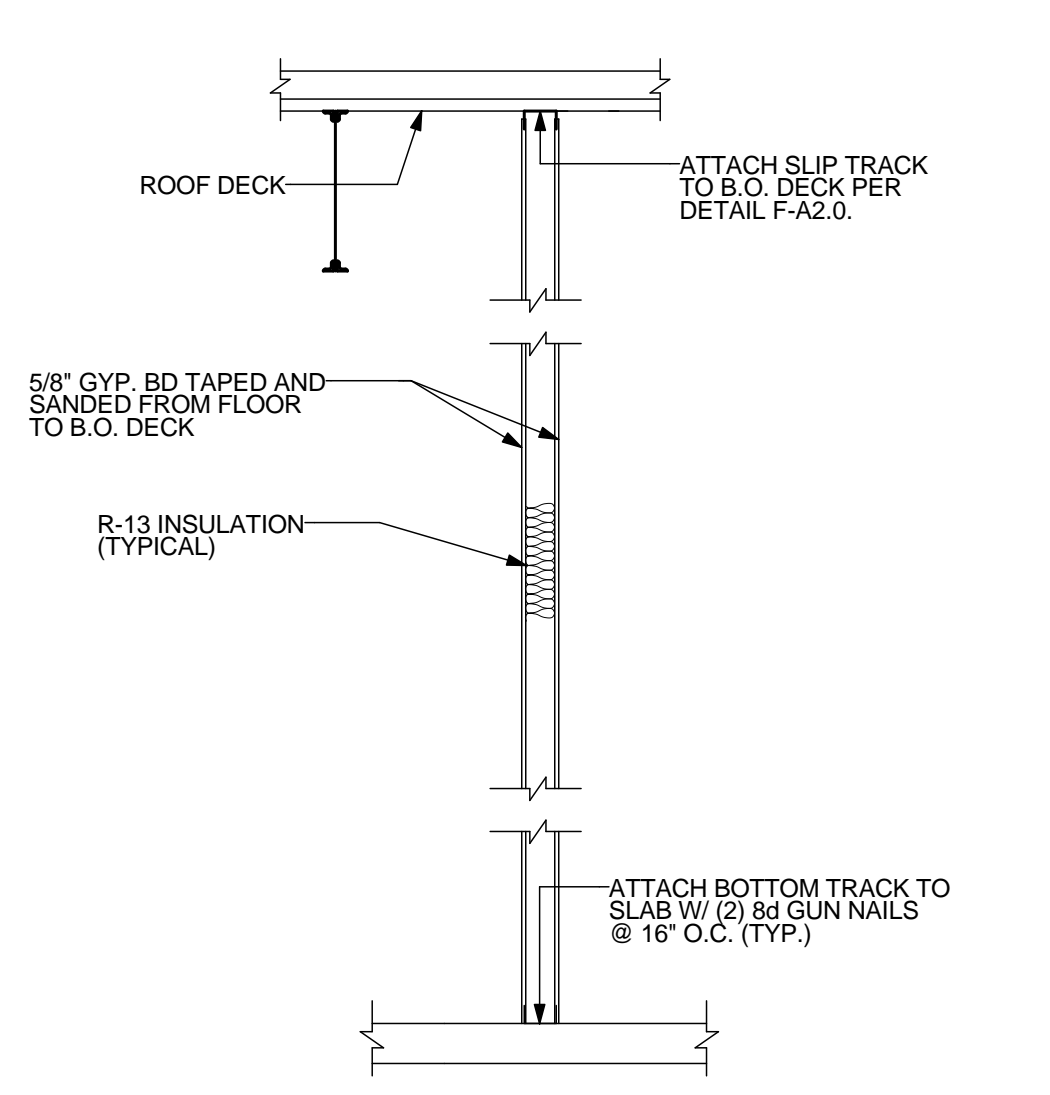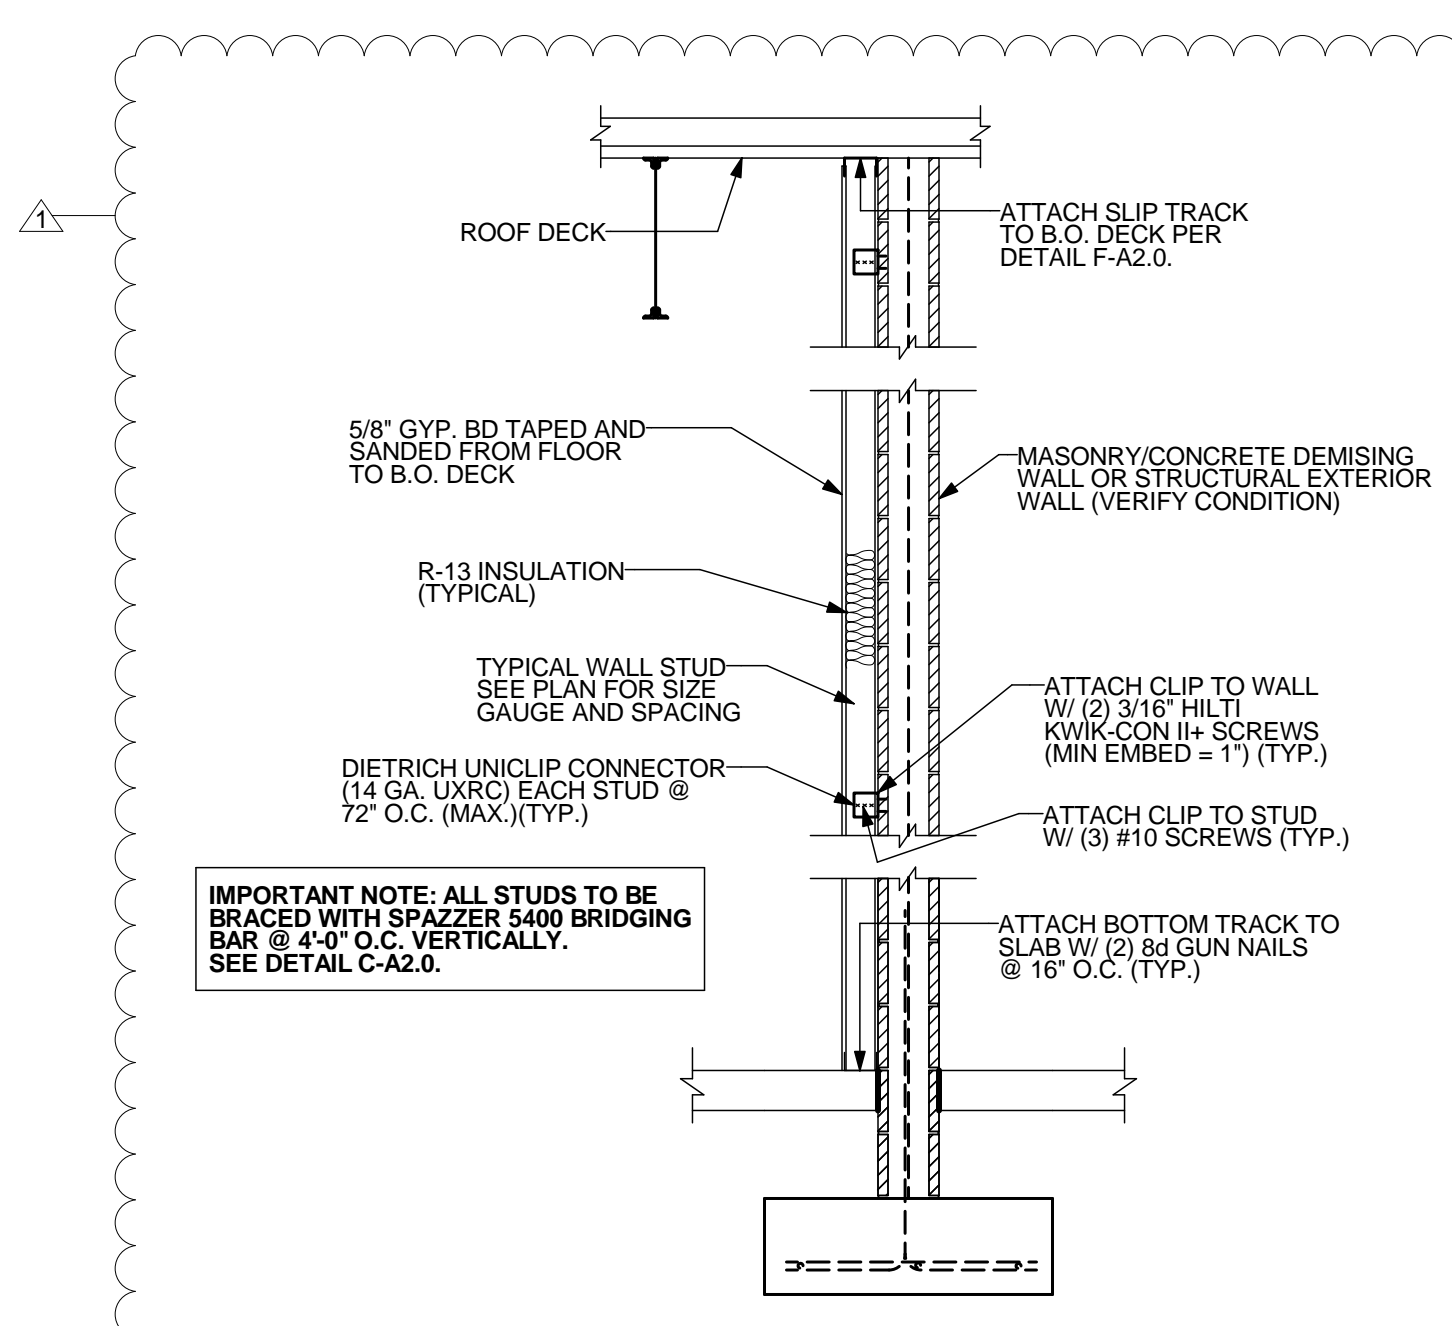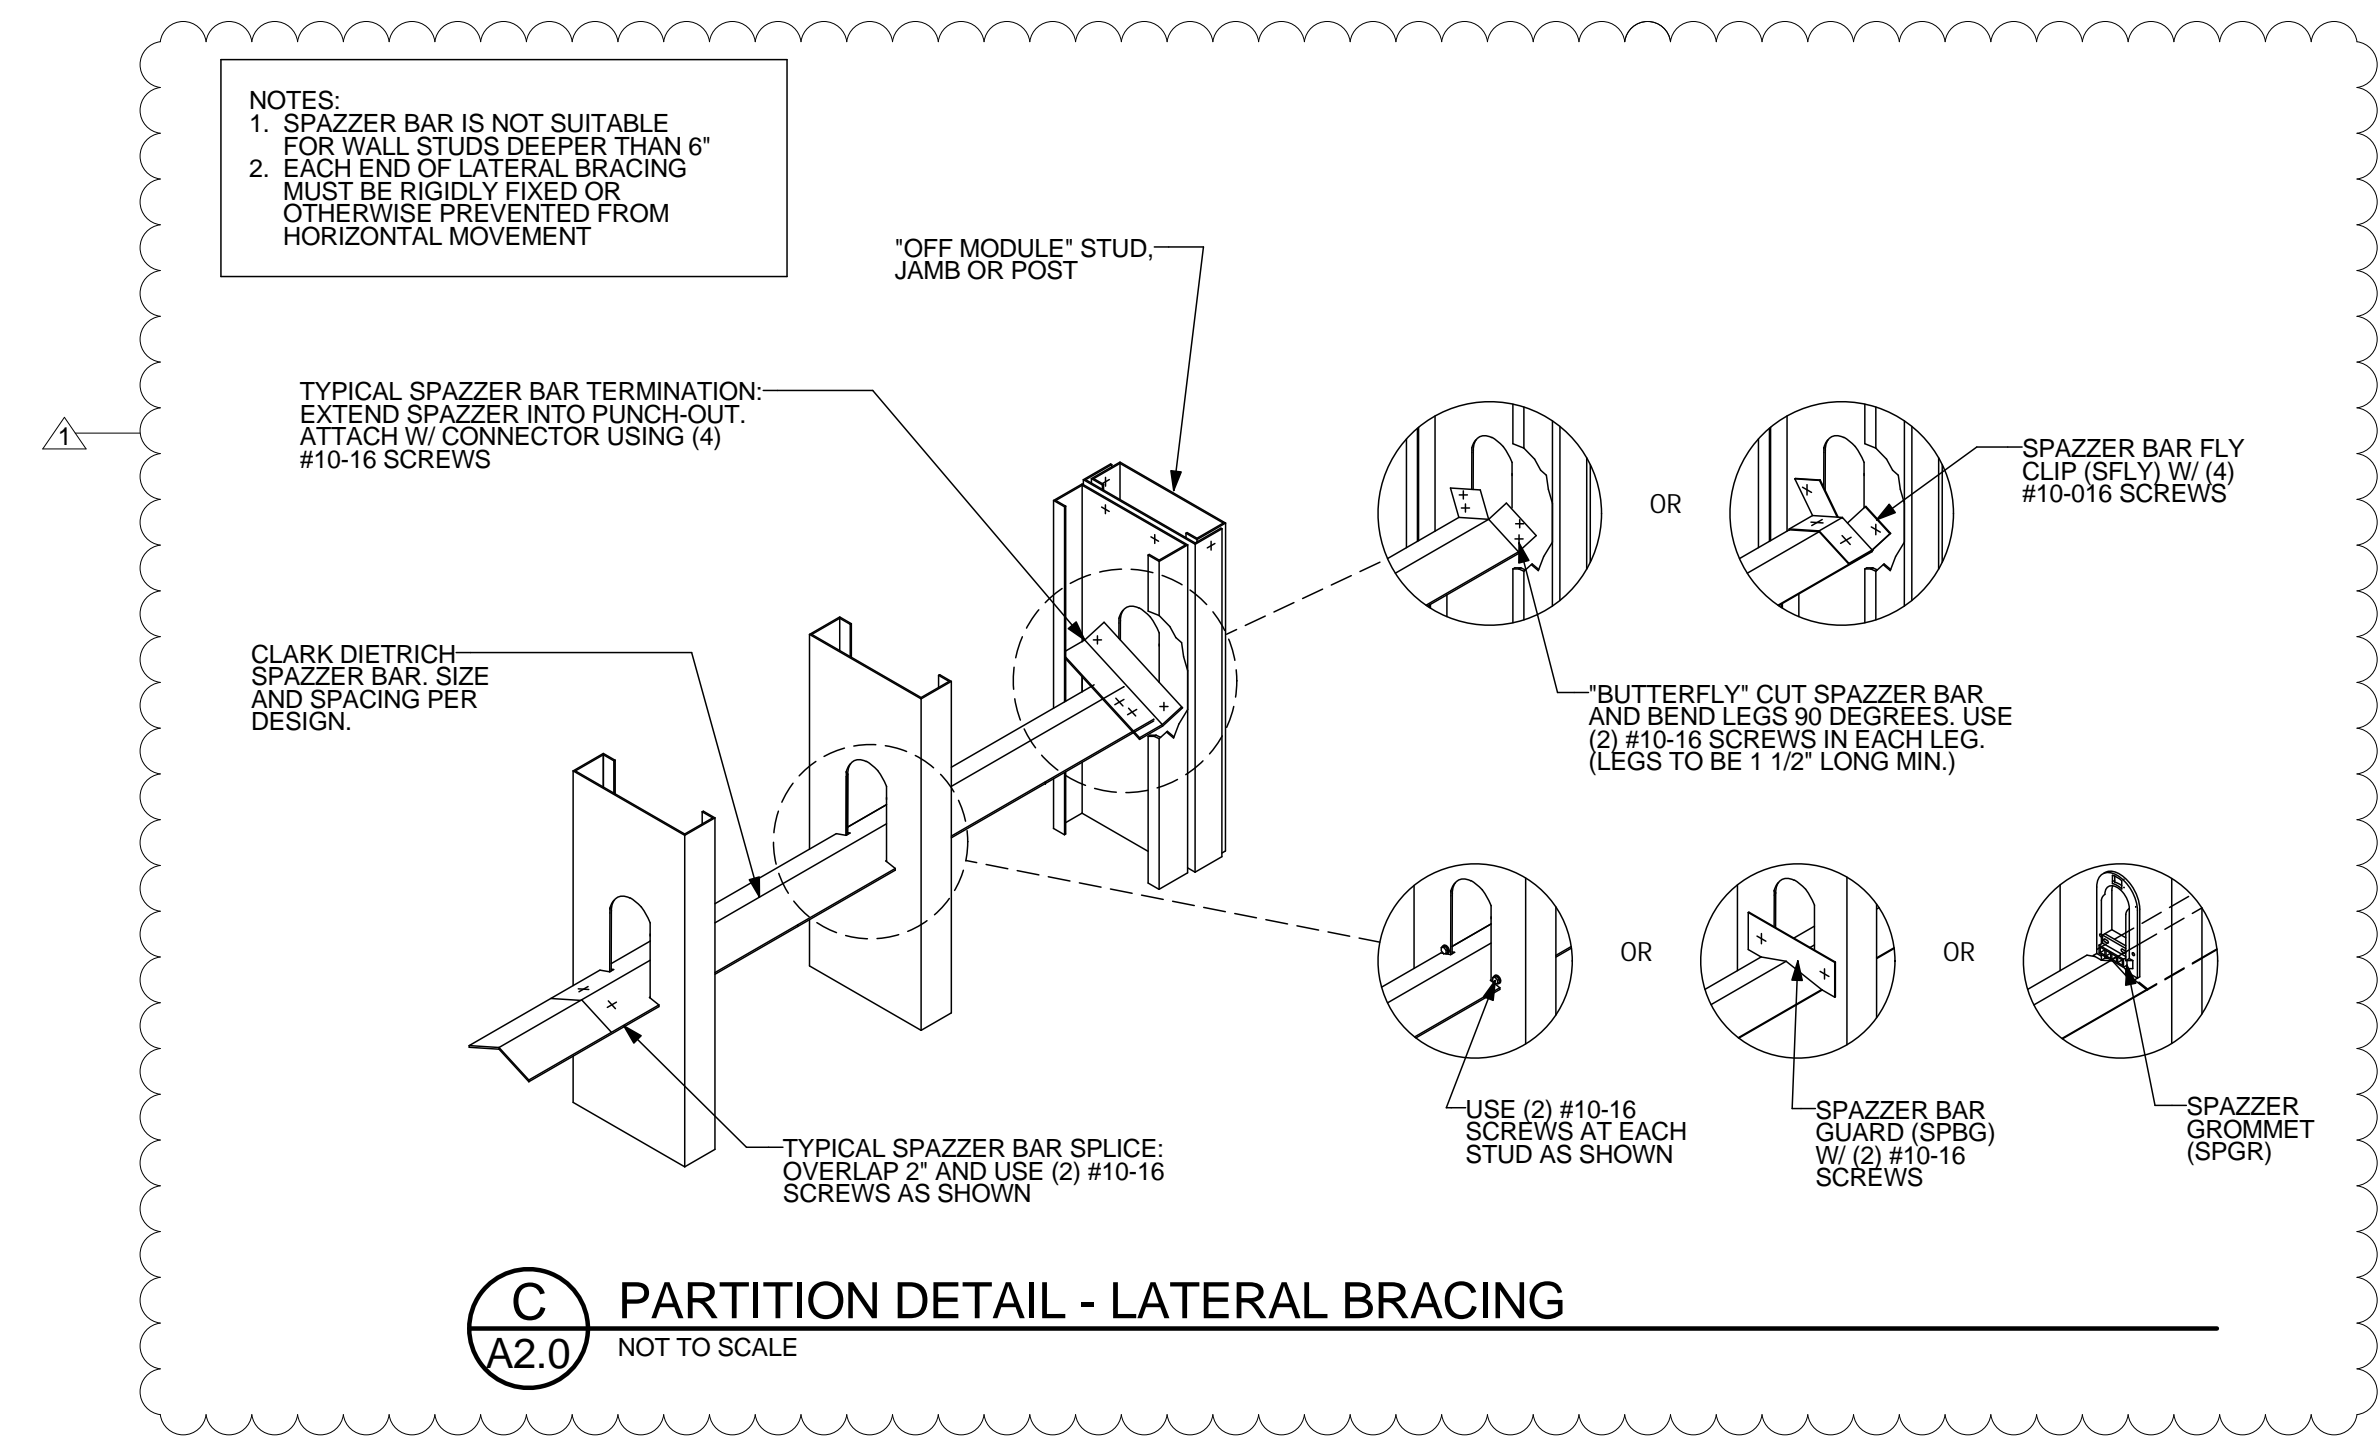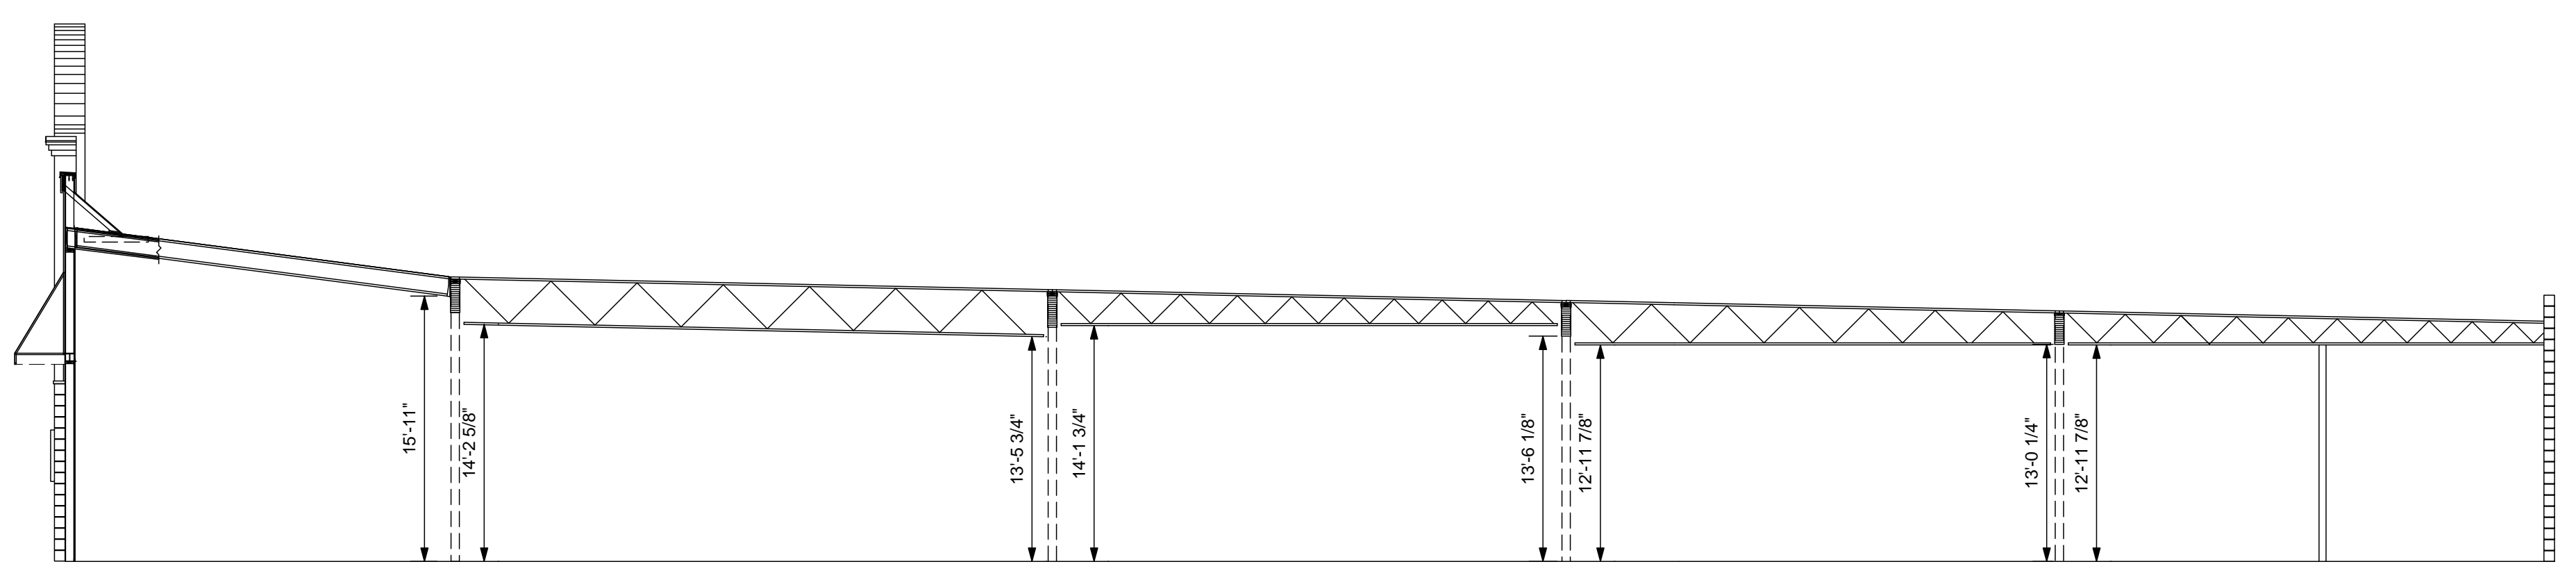

PROJECT: ULTA BEAUTY TI - (SHELL PACKAGE)
LOCATION: 2870 S 6TH STREET, KLAMATH FALLS, OR 97603

SHEET TITLE: ELEVATION, SECTION AND MISC. DETAILS
CLIENT: DICKERHOOF PROPERTIES

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A2.0